



G1 WALL SECTION - AREA "C" THRU WINDOW
3/4" = 1'-0"

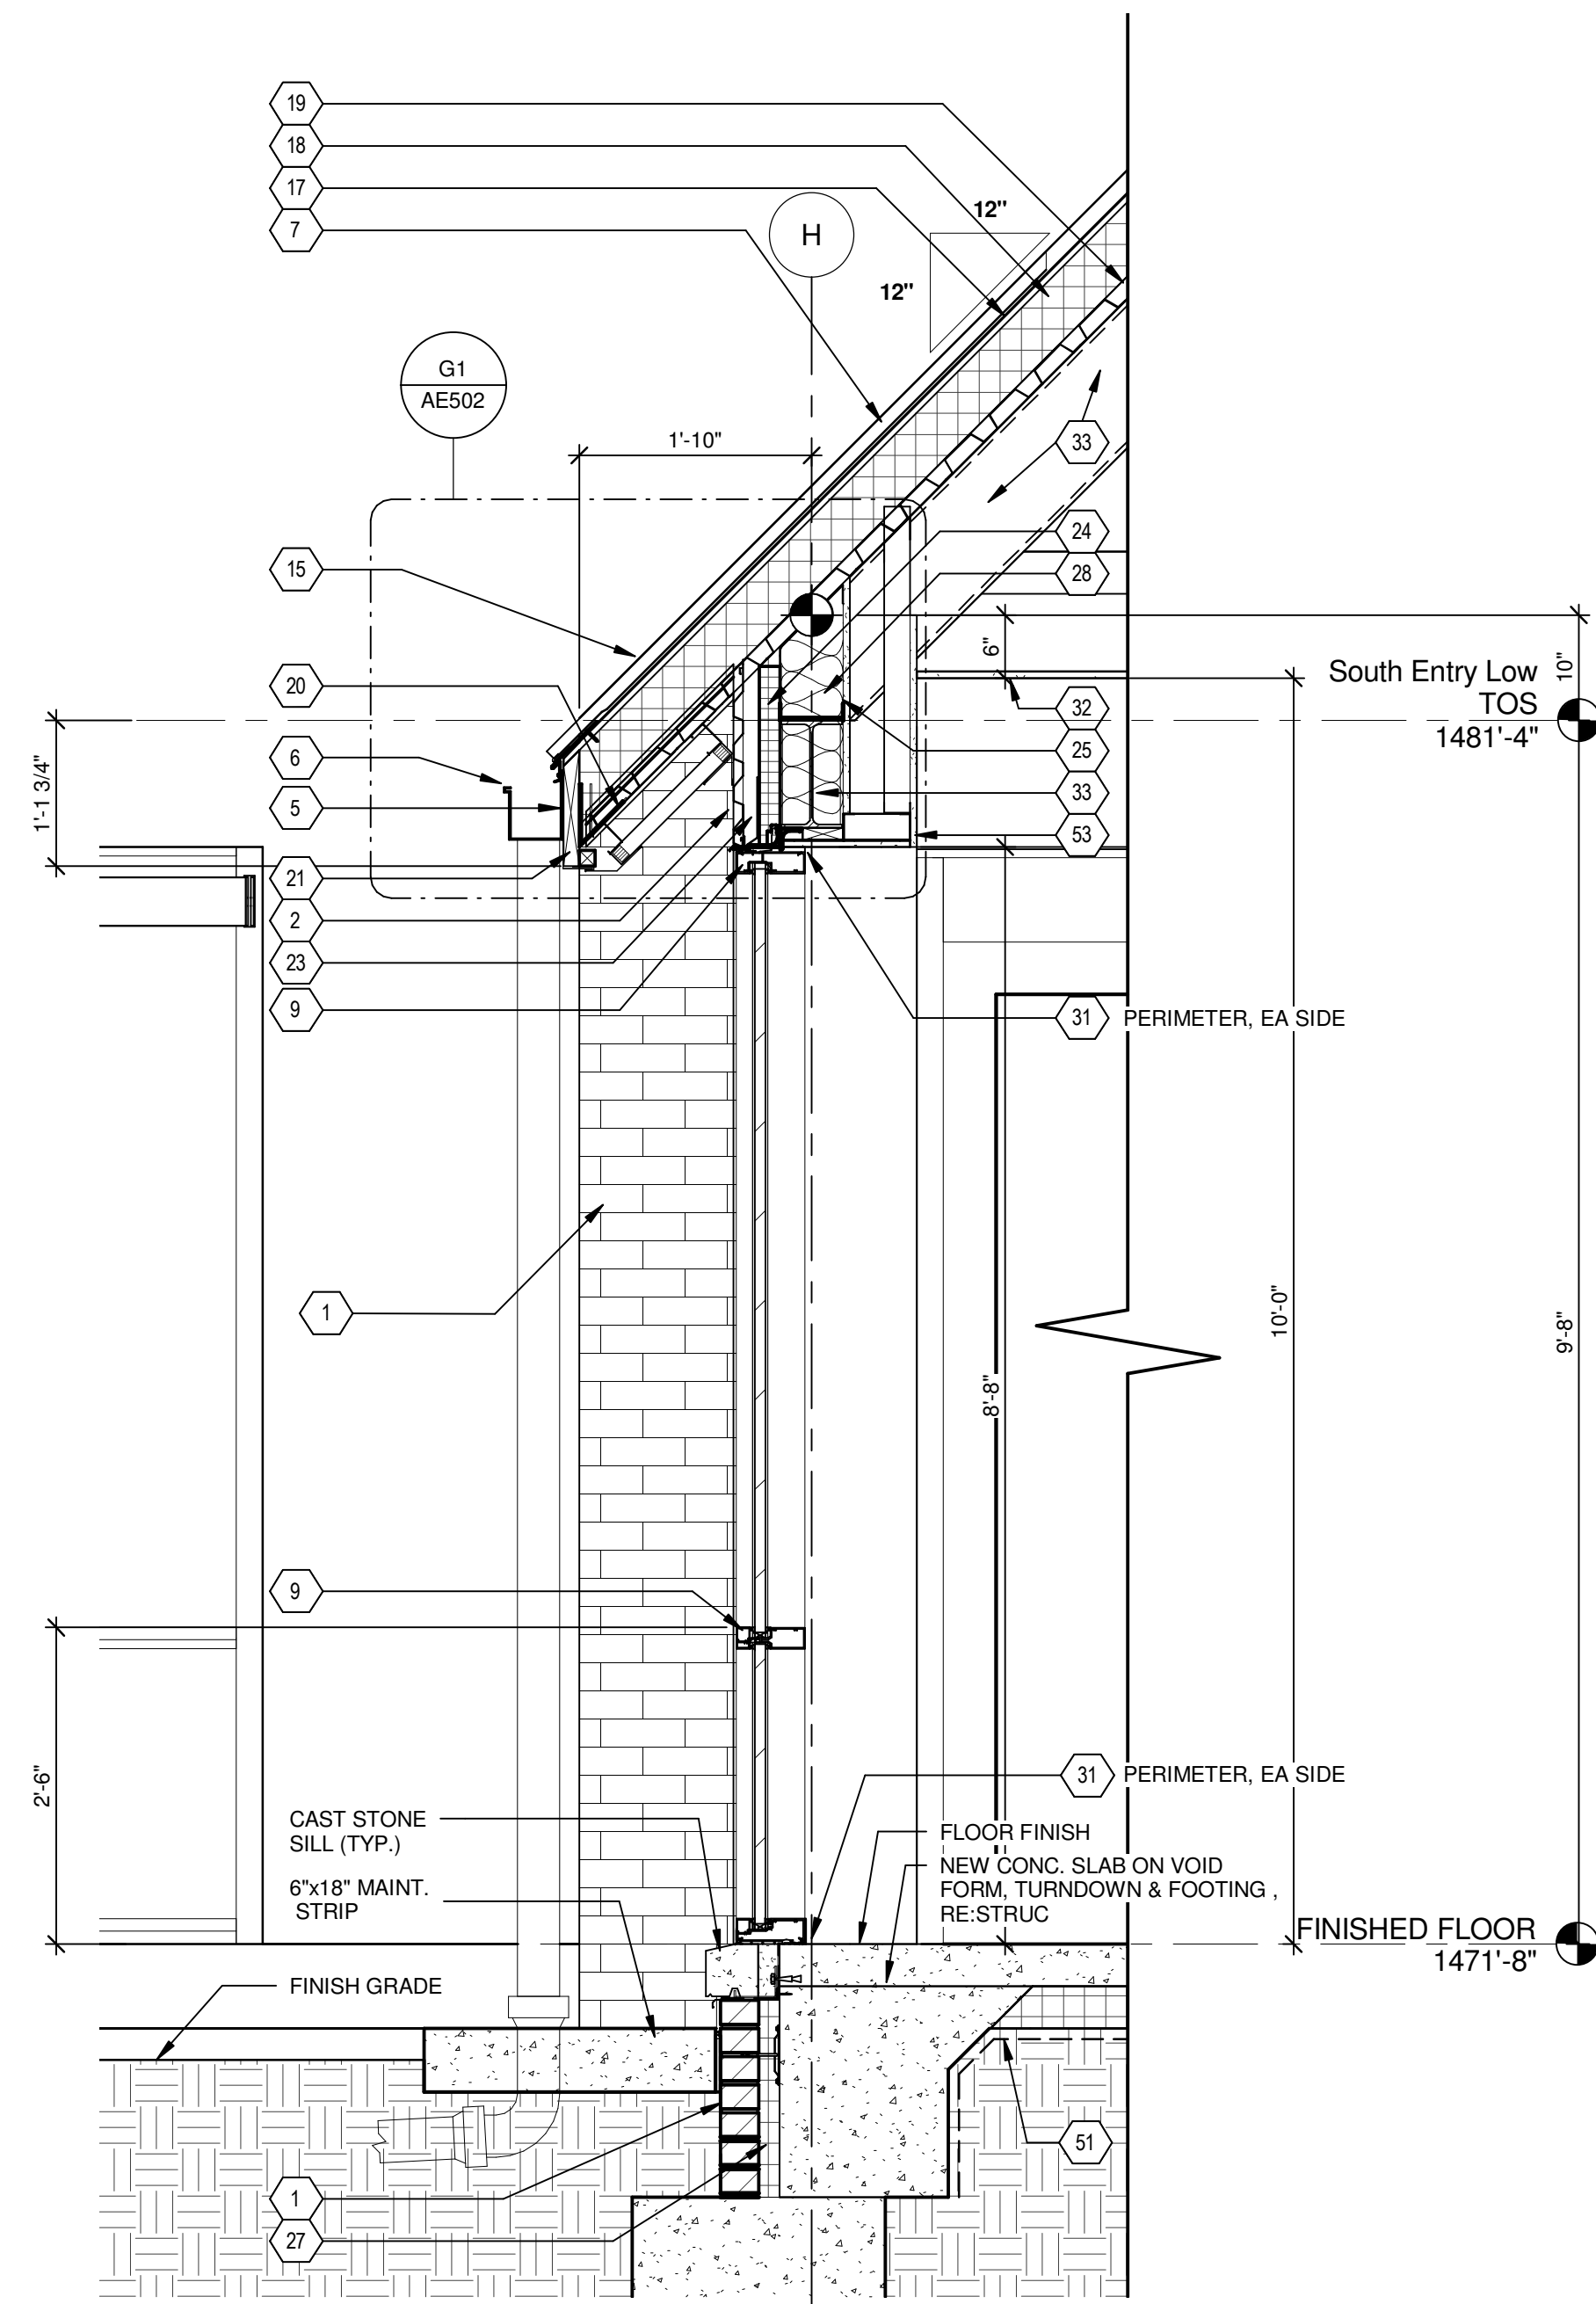

G3 WALL SECTION @ ENTRY VESTIBULE 101
3/4" = 1'-0"

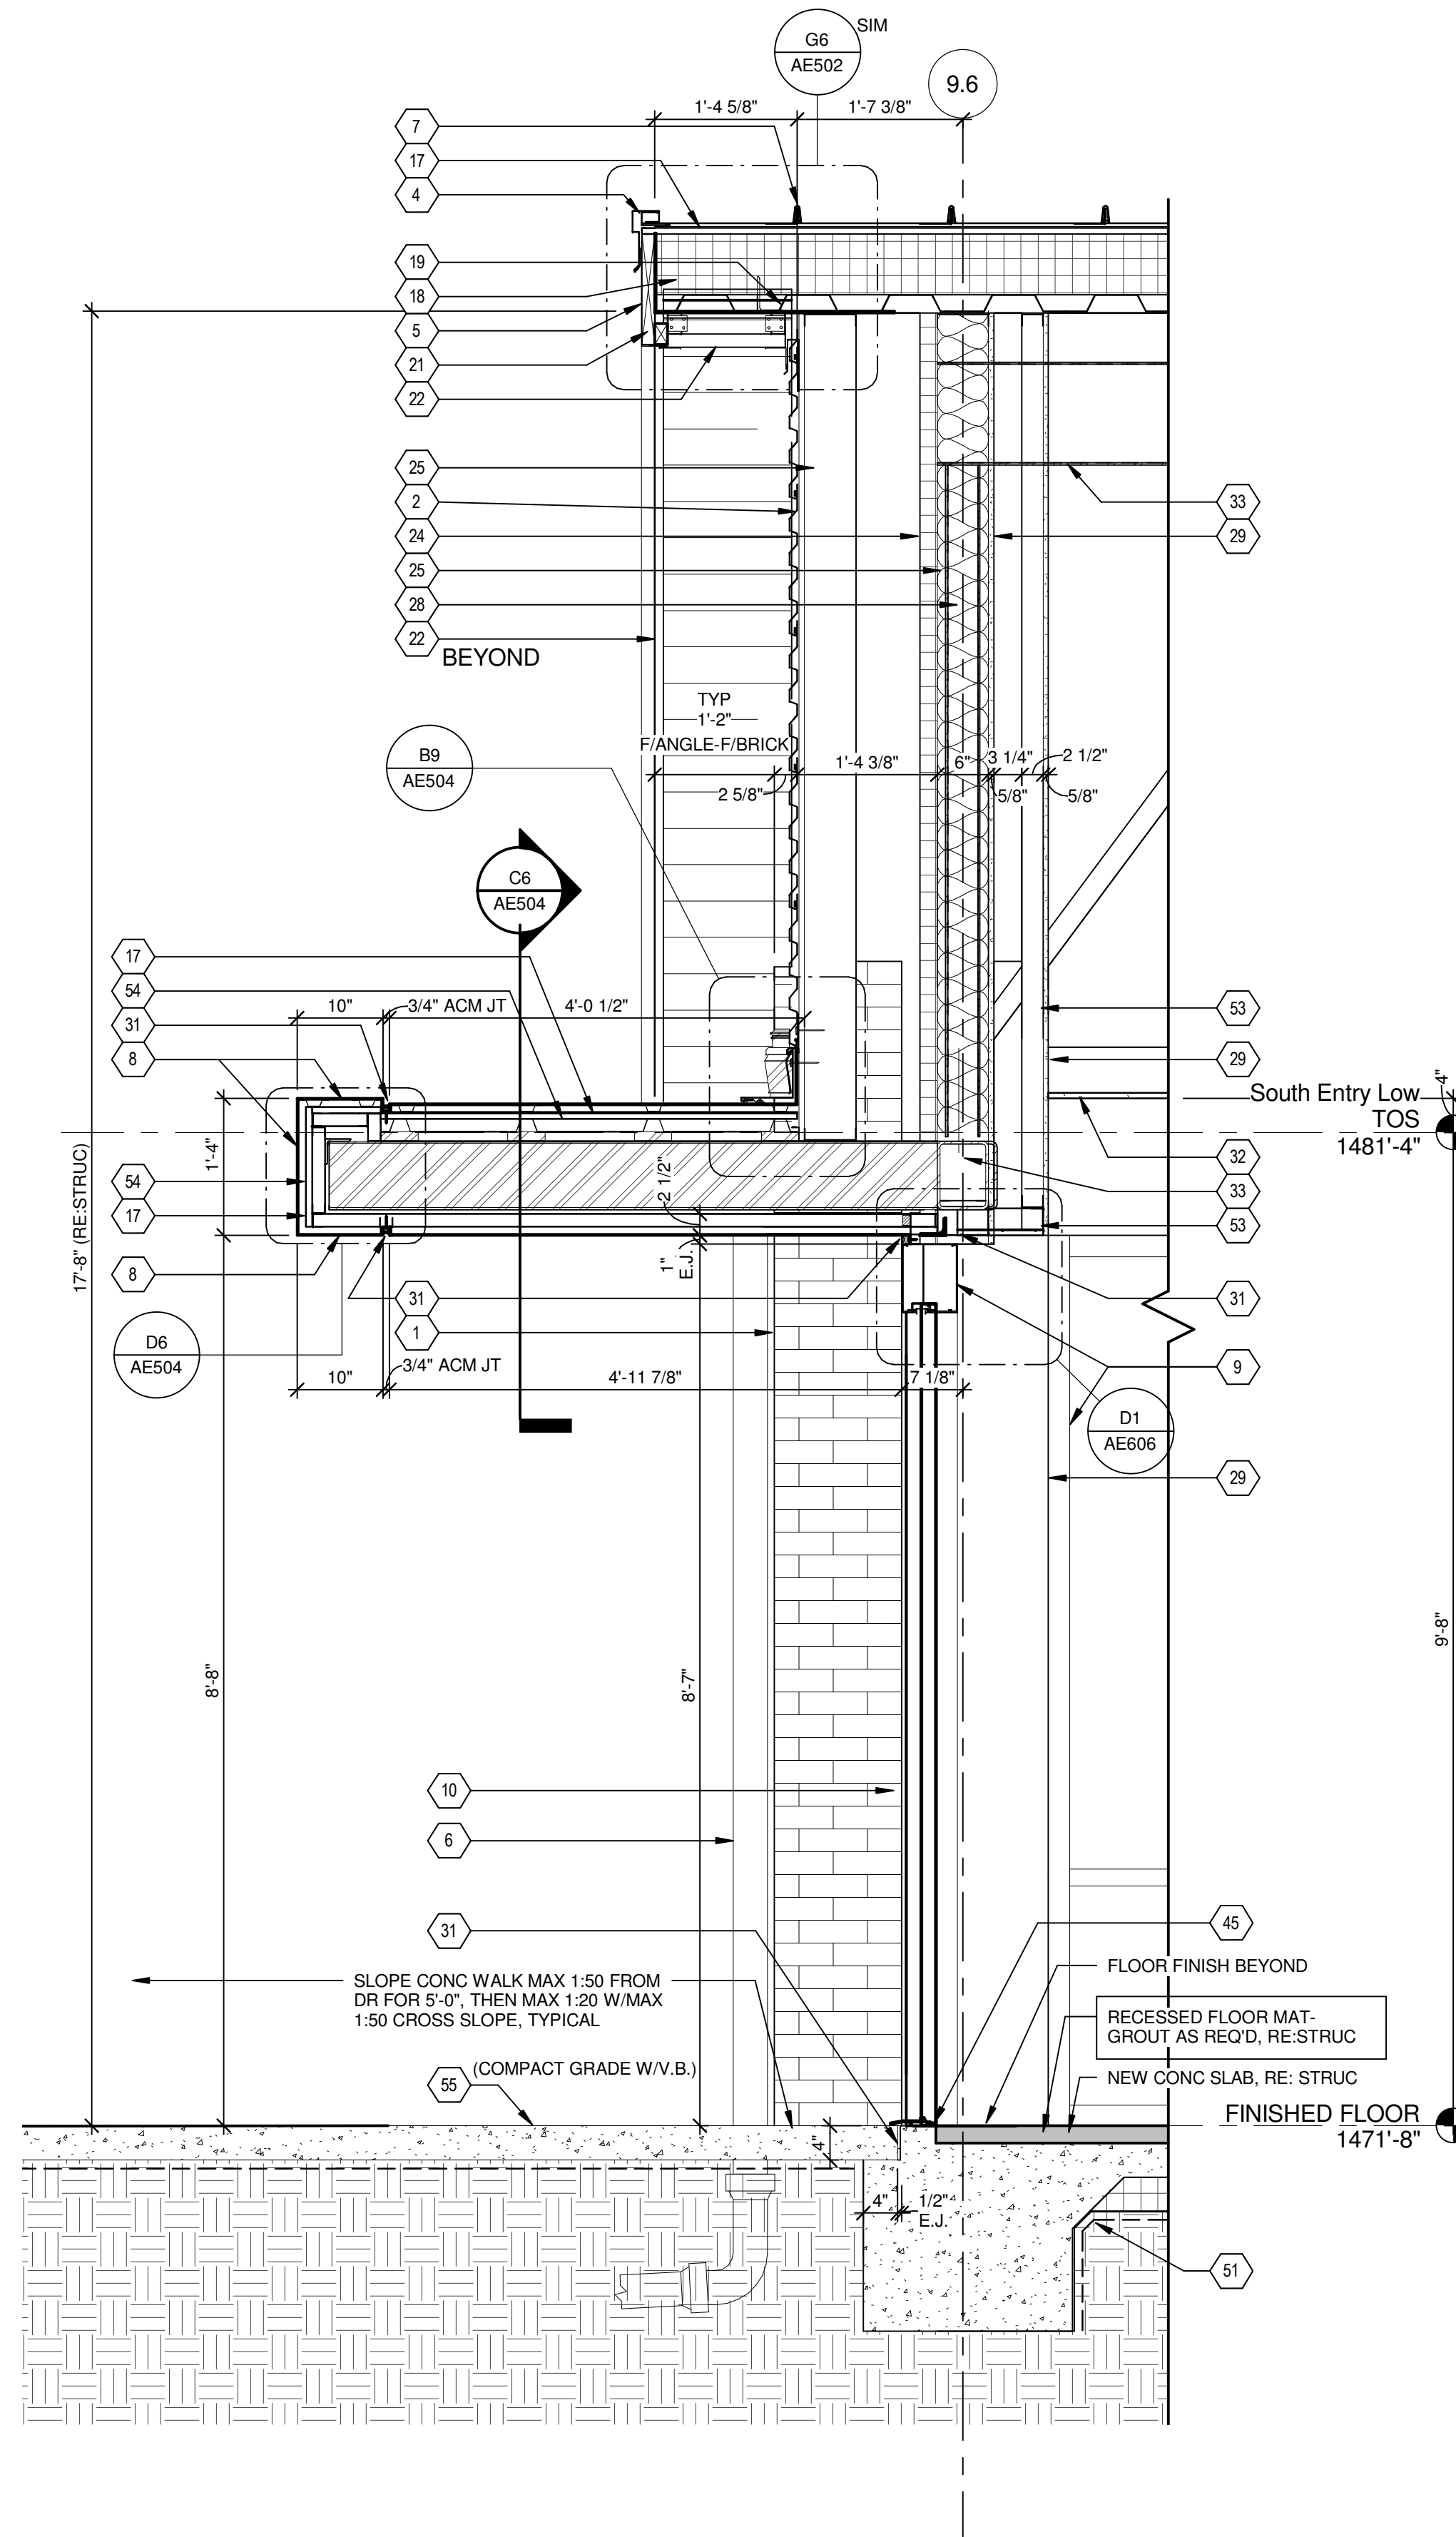

G6 WALL SECTION @ ENTRY VESTIBULE 101 - CANOPY
3/4" = 1'-0"

KEYED WORK NOTES (RE:DETAILS FOR ADDITIONAL INFORMATION)

- 1 NEW BRICK VENEER w/GALV ADJ ANCH SYS 16" OC VERT, 32" OC HORIZ
- 2 PREFINISHED METAL HORIZONTAL WALL PANELS & TRIM SYSTEM RE: B9/AE501
- 3 ALUMINUM COMPOSITE METAL (ACM) PANEL SYSTEM
- 4 PREFINISHED METAL ROOF / WALL FLASHING
- 5 PREFINISHED METAL FASCIA
- 6 PREFINISHED METAL GUTTER & DOWNSPOUT (TIE DOWNSPOUTS INTO STORM WATER SYSTEM)
- 7 PREFINISHED 1-1/2" STANDING SEAM METAL ROOF PANEL
- 8 ALUMINUM COMPOSITE METAL (ACM) PANEL CANOPY SYSTEM
- 9 ALUMINUM STOREFRONT SYSTEM, SEE FLOOR PLAN FOR TYPE
- 10 ALUMINUM ENTRANCE DOOR
- 11 INSULATED HOLLOW METAL DOOR AND FRAME, PAINT
- 12 REPLACE EXISTING GUTTER & DOWNSPOUT w/PREFINISHED METAL GUTTER & DOWNSPOUT (TIE DOWNSPOUTS INTO STORM WATER SYSTEM & REPAIR/MODIFY EXISTING ROOF CONNECTION)
- 13 LOUVER - BLANK OFF UNUSED PORTIONS
- 14 1-1/2" EXPANSION JOINT AND COVER
- 15 ICE CLEATS
- 16 SUNSHADE BY STOREFRONT MANUFACTURER
- 17 CONTINUOUS ICE AND WATER SHIELD MEMBRANE
- 18 R-30, 5 1/2" NAIL BASE ROOF INSULATION (EXTEND WD DECK OVER TOP OF FASCIA BLOCKING)
- 19 1 1/2" GALV METAL ROOF DECK
- 20 CONTINUOUS BENT PLATE OR ANGLE SUPPORT, RE: STRUC
- 21 CONTINUOUS TREATED WOOD FRAMING
- 22 CONTINUOUS PREFINISHED METAL SOFFIT & TRIM RE: B7/AE501
- 23 1-1/2" GALV METAL 2" FURRING, 16" O.C., ANCHOR SECURELY TO INSULATED BACKUP PANEL CLIPS PER PANEL MANUF SPECIFICATIONS
- 24 2" INSULATED-CORE METAL WALL BACKUP PANEL SYSTEM (R-14) w/FLEXIBLE MEMBRANE FLG AND FASTENER SEAL PER MANUF, ANCHOR SECURELY 16" O.C. PER MANUF, TYPICAL
- 25 EXTERIOR 6" x 18 GA GALV METAL STUDS, 16" O.C. w/CONT TRACK AT ENDS. NOTE: AT BLDGS 18" & C", INSTALL STUD SUPPORT CLIPS AT EXIST CMU WALLS (WHERE OFFSET) TO MEET OR EXCEED STUD L/360 STIFFNESS RATIO.
- 26 FLUID APPLIED VAPOR PERMEABLE MEMBRANE AIR BARRIER
- 27 CONTINUOUS 2" RIGID INSULATION w/LAPPED EDGES, ANCHOR SECURELY TO WALL PER MANUF
- 28 SPRAYED CELLULOSE INSULATION, FILL STUD DEPTH & ALL CAVITIES AT INSULATED WALLS, PROVIDE SUPPORT BLOCKING AS REQUIRED BY MANUF
- 29 5/8" GYPSUM WALLBOARD, REFER TO LIFE SAFETY PLAN FOR RATED GWB LOCATIONS
- 30 5/8" GYPSUM WALLBOARD CEILING ON 1-1/2" x 18 GA HAT CHANNELS, 24" O.C. WITH R-30 SPRAYED CELLULOSE INSULATION ABOVE, ANCHOR CHANNEL SECURELY AT EACH EXISTING ROOF TRUSS JOIST. (NOTE: AT 48" O.C., ANCHOR CHANNELS SECURELY WITH ONE S.S. ALL-THREAD ROD 24" x 3/8" DIA AND TWO STRUC S.S. NUTS WITH PLATE WASHERS SIZED FOR INSTALLATION NEAR TRUSS PANEL POINTS BETWEEN JOIST BARS OR ANGLES AT BOTTOM CHORD. - HANG REMAINDER OF ROD BELOW CEILING FOR FULL SUPPORT OF LOWER CEILING, MEP SYSTEMS, SEISMIC OR OTHER BRACING, APPURTENANCES & OTHER LOADS).
- 31 CONTINUOUS SEALANT AND BACKER ROD
- 32 FINISH CEILING, RE: REFLECTED CEILING PLAN
- 33 NEW STRUC SUPPORT MEMBER, RE: STRUC
- 34 EXTERIOR 3 5/8" x 18 GA GALV METAL STUDS, 16" O.C. w/CONT TRACK AT ENDS
- 35 INTERIOR 3 5/8" x 20 GA GALV METAL STUDS, 16" O.C. w/CONT TRACK AT ENDS
- 36 INTERIOR 7/8" x 20 GA GALV METAL HAT CHANNELS, 16" O.C.
- 37 GALVANIZED ADJUSTABLE ANCHORING SYSTEM AT MET WALL PANEL JOINT CLIPS & ON PANEL FACE BETWEEN. INSTALL PER MET WALL PANEL MANUFACTURER'S WARRANTED SYSTEM
- 38 EXTERIOR 8" x 18 GA GALV METAL STUDS, 16" O.C. w/CONT TRACK AT ENDS
- 39 EXISTING ROOF TO REMAIN
- 40 EXISTING STRUCTURE TO REMAIN
- 41 EXISTING MASONRY WALL TO REMAIN
- 42 NEW LINTEL(S)
- 43 HOLLOW METAL FRAME
- 44 INSULATED HOLLOW METAL DOOR
- 45 METAL THRESHOLD - SET IN SEALANT BED
- 46 MEMBRANE FLASHING
- 47 SYNTHETIC SILL - BULLNOSE EDGE
- 48 PREFINISHED METAL SILLS
- 49 FLOOR FINISH
- 50 BASE
- 51 VAPOR BARRIER (10 MIL MINIMUM THICKNESS)
- 52 VOID FORMS, REFER TO STRUCTURAL
- 53 INTERIOR FURRING: 5/8" GWB ON 2 1/2" x 20 GA GALV METAL FRAMING, 16" O.C. w/CONT TRACK AT ENDS
- 54 CONT 3/4" TREATED EXTERIOR PLYWOOD SHEATHING OR DECKING
- 55 CONCRETE SLAB ON 10 MIL VAPOR BARRIER & MIN 4" COMPACTED DRAINAGE FILL, RE:STRUC

CONSULTANTS: 		09/07/2012	ARCHITECT / ENGINEERS: 		Drawing Title WALL SECTIONS	Project Title Renovate Leroy Pond Army Reserve Center for Mental Health Residential Rehabilitation Treatment/ Police Training		Project Number 564-341	Office of Facilities Management DEPARTMENT OF VETERANS AFFAIRS
					Approved: Project Director	Location Fayetteville, AR		Building Number 	
						Date 9/7/12		Drawing Number AE308	
						Checked SG		Dwg. 67 of 126	

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